


TYPICAL SECTION THRU SLAB
(SHOWING CURTAILMENT OF BARS)


SCALE: 1:25

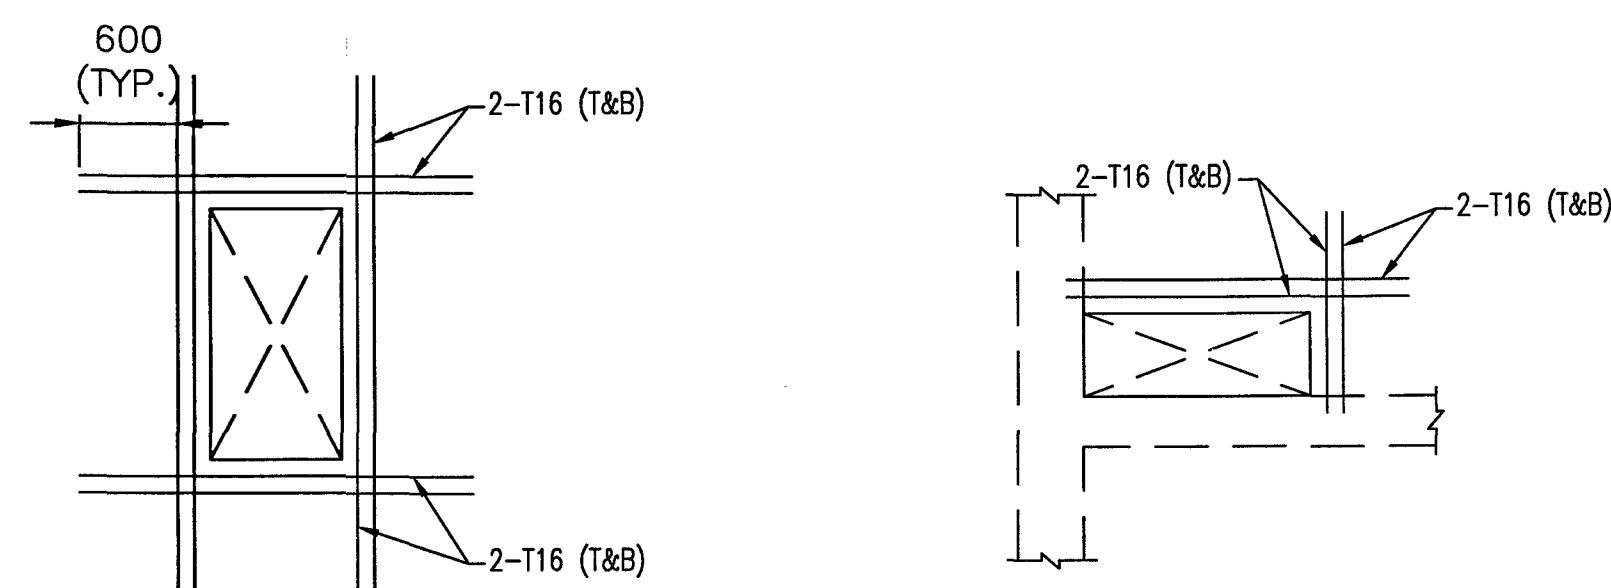

TYPICAL CUT OUT REINFORCEMENT DETAILS

SCALE: 1:50

LEGEND

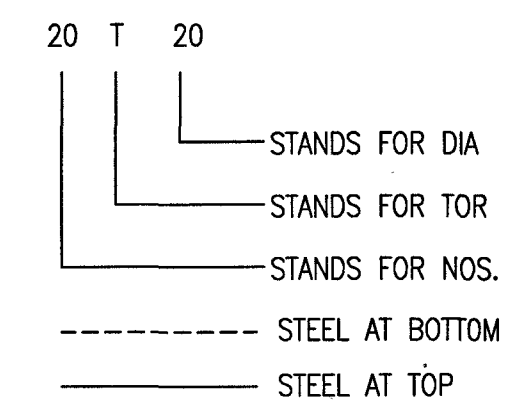

NOTES:-

- UNLESS NOTED OTHERWISE
- FOR GENERAL NOTES REFER DRG. NO.1020.01/S/GN/001, GN/002,
- FOR STANDARD DETAILS REFER DRG.NO.1020.01/S/SD/001
- COLUMN DETAIL AND SIZES REFER DRG.NO.1020.01/S/C-1
- ALL DIMENSIONS ARE IN MILLIMETRES AND LEVELS ARE IN METRES.
- DIMENSIONS ARE NOT TO BE SCALED AND FOLLOW THE WRITTEN DIMENSIONS ONLY.
- ALL SETTINGS OUT COLUMNS WALLS, DIMENSION AND LEVELS SHALL BE READ IN CONJUNCTION WITH ARCH. DRAWINGS.
- FOR ALL THE OPENINGS DROPS, SUMPS & PITS REF. RELEVANT CONSULTANT DRG. TO BE CONFIRMED BY ARCHITECTS /ENGINEER INCHARGE.
- CONC. MIX = M 30
- COVER OF SLAB 20mm.

LEGEND:-

- XXX SLAB THICKNESS
- RC COLUMN UNDER/OVER
- RC COLUMN BELOW
- SLAB LEVEL
- SHEAR WALL
- CUTOUT IN SLAB

DATE OF ISSUE

22-09-2006

MEINHARDT

FOR CONSTRUCTION ONLY

0 22.09.06 PKS FOR CONSTRUCTION SDK

SCHEDULE OF SLAB REINFORCEMENT

A	T10 @ 100 C/C
B	T10 @ 125 C/C
C	T10 @ 150 C/C
D	T10 @ 175 C/C
E	T10 @ 200 C/C
F	T10 @ 250 C/C
G	T8 @ 200 C/C
H	T8 @ 250 C/C
I	T10 @ 120 C/C
K	T12 @ 150 C/C
L	T12 @ 200 C/C
M	T12 @ 100 C/C
N	T16 @ 150 C/C
P	T16 @ 100 C/C


GROUND FLOOR SLAB REINFORCEMENT PLAN

AS SHOWN

PKS JULY 2006
RAV JULY 2006
SDK JULY 2006
CC T:1 JULY 2006

1020.01 S G-2

Recd 25/9/06
from Ho
[Signature]

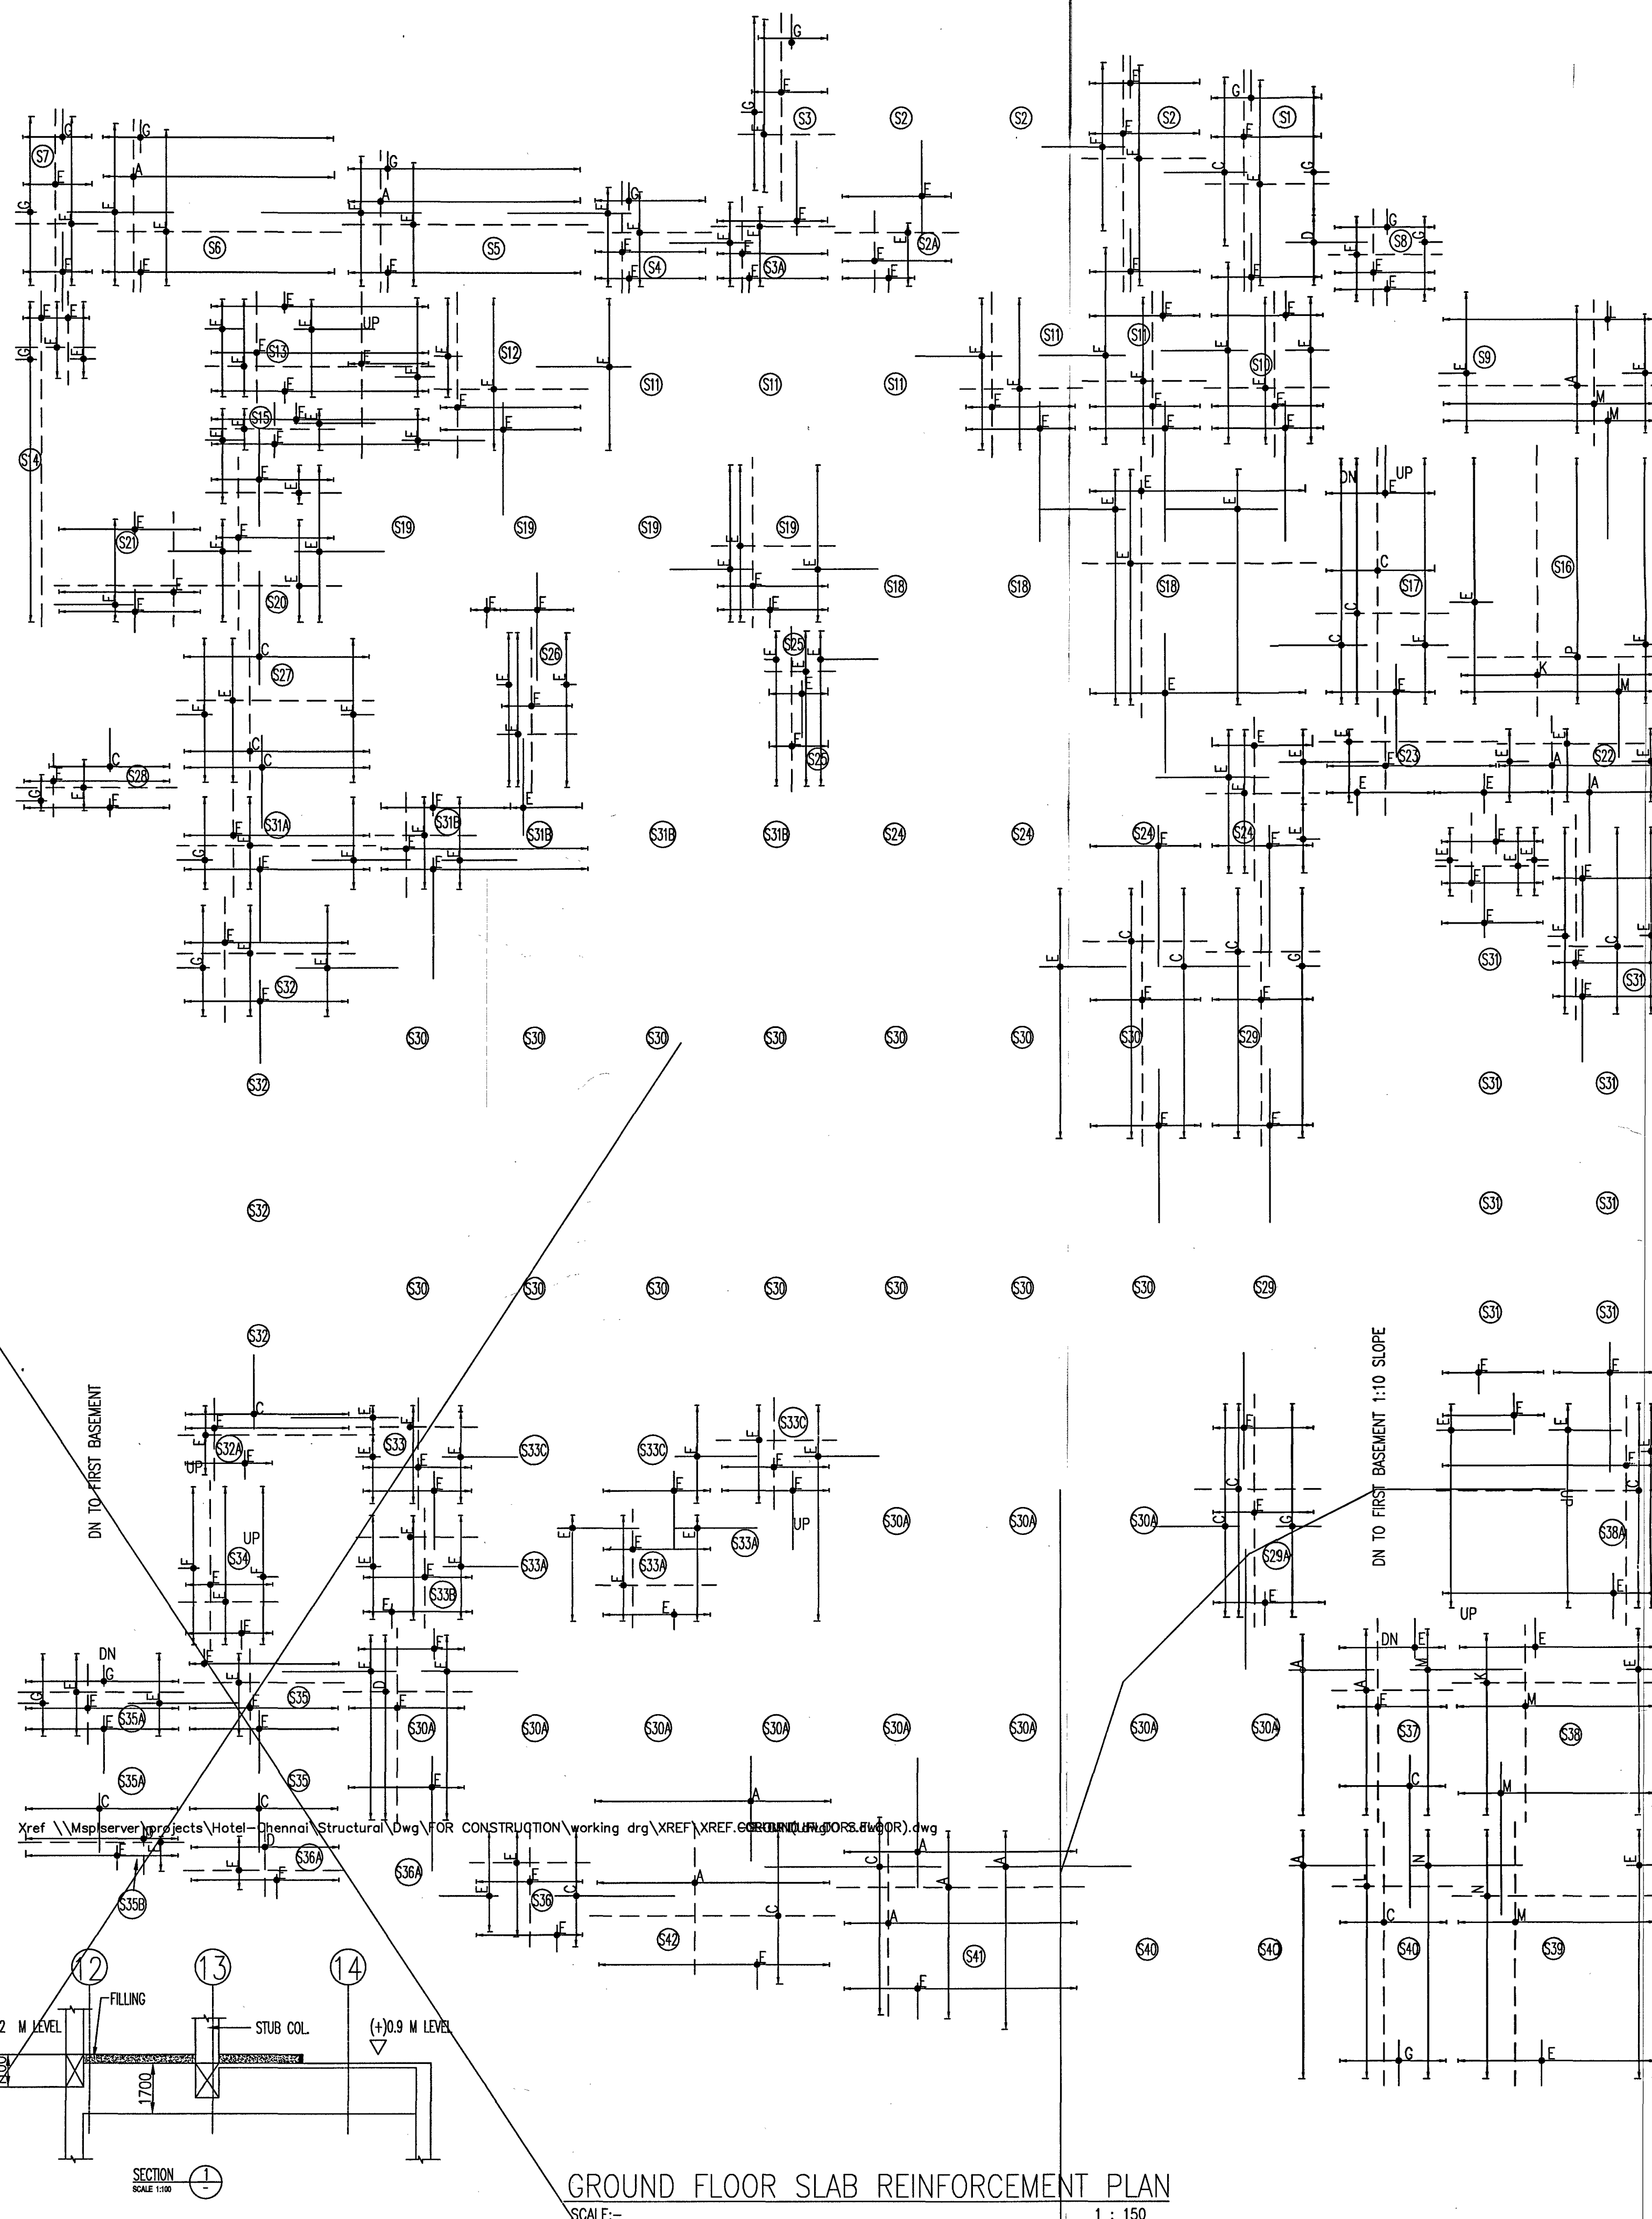

GROUND FLOOR SLAB REINFORCEMENT PLAN

SCALE: 1:150